

l	VER	BY	AMENDMENTS	DATE		
	Α	ВС	16-02-2024			
	В	ВС	28-02-2024			
	O	SG	AMENDMENT TO DRAINAGE EASEMENTS	24-05-2024		
D BC ADDED LOT 101		вс	ADDED LOT 1017	26-08-2024		
	Е	вс	AMENDMENT TO DRAINAGE EASEMENTS	01-10-2024		






LOT 2 DP1291984 AND LOT 1 DP101147 2 BULLECOURT AVENUE, MILPERRA (STAGE 1)

; ;	ORIGINA SCALE 1:2500

SHEET SIZE
А3

SURVEYOR:	ВС
DRAWN:	DH
CHECKED:	BC
SURVEY DATE:	N/A
CAD REFERENCE:	2301879(1)-PS
SHEET 1 C	OF 2

	PROJECT №. 2301879
	DRAWING REF. 2301879(1)-PS
1	VERSION F

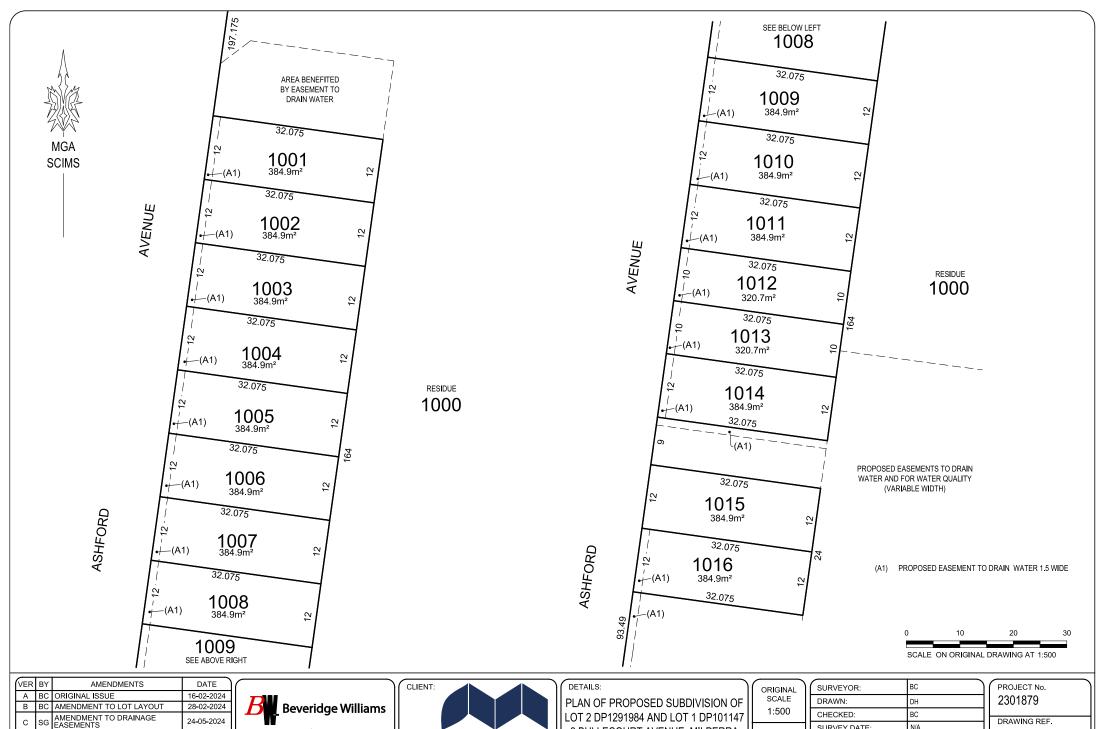

VER BY AMENDMENTS		AMENDMENTS	DATE
Α	ВС	ORIGINAL ISSUE	16-02-2024
В	28-02-2024		
С	SG	AMENDMENT TO DRAINAGE EASEMENTS	24-05-2024
D	вс	ADDED LOT 1017	26-08-2024
Ш	вс	AMENDMENT TO DRAINAGE EASEMENTS	01-10-2024



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2 BULLECOURT AVENUE, MILPERRA (STAGE 1)


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SHEET SIZE

SURVEYOR:	BC
DRAWN:	DH
CHECKED:	BC
SURVEY DATE:	N/A
CAD REFERENCE:	2301879(1)-PS
SHEET 2 C	OF 2

2301879	
DRAWING REF.	
2301879(1)-F	PS
VERSION E	

# WSU MILPERRA

# CONCEPT CIVIL ENGINEERING PLANS TO SUPPORT THE STAGE 1 SUBDIVISION LOT 2 IN DP1291984 - 2 BULLECOURT AVENUE, MILPERRA CANTERBURY-BANKSTOWN COUNCIL MIRVAC HOMES (NSW) PTY LTD

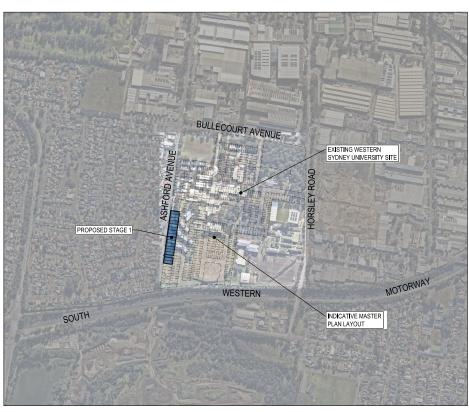

### DRAWING INDEX

Sheet No.	neet No. DRAWING No. TITLE		REVISION
1	2301879 - 303 - 001	COVER SHEET	D
2	2301879 - 303 - 002	DEMOLITION PLAN	D
3	2301879 - 303 - 011	LAYOUT PLAN	D
4	2301879 - 303 - 012	BULK EARTHWORKS AND LOT BENCHING PLAN	D
5	2301879 - 303 - 101	ASHFORD AVENUE BACK OF KERB - LONGITUDINAL SECTION - & TYPICAL CROSS SECTION	D
6	2301879 - 303 - 201	LOT CROSS SECTIONS - SHEET 1 OF 5	D
7	2301879 - 303 - 202	DT CROSS SECTIONS - SHEET 2 OF 5	
8	2301879 - 303 - 203	LOT CROSS SECTIONS - SHEET 3 OF 5	D
9	2301879 - 303 - 204	OT CROSS SECTIONS - SHEET 4 OF 5	
10	2301879 - 303 - 205	LOT CROSS SECTIONS - SHEET 5 OF 5	D
11	2301879 - 303 - 301	DETENTION BASIN LAYOUT PLAN	
12	2301879 - 303 - 401	SOIL AND WATER MANAGEMENT PLAN - OVERALL PLAN	
13	2301879 - 303 - 402	SOIL AND WATER MANAGEMENT PLAN - STAGE 1 PLAN	
14	2301879 - 303 - 403	403 SOIL AND WATER MANAGEMENT PLAN - DETAILS & NOTES	

SITE PLAN

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Designed	S. FERGUSON	7711
Date	06.03.2024	<b>B</b> eve
Drawn	J. BIRD	
Approved	S. GRAY	Development & In
Date	08.03.2024	
DA Number		Level 4, LPC House, Suite 4.05, 3 Fr Oran Park NSW 2570


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RD	
AY	Development & Infrastructure Consultants


Project Details	WSU MILPERRA, LOT 2 IN DP1291984 2 BULLECOURT AVE, MILPERRA STAGE 1 SUBDIVISION	
Drawing	COVER SHEET	

Sheet 01 of 14
Scale
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2301879 303 001 D

Q1ws/gbts/20201879 - 2 Bullisouri Avenue Mibernii, Eng/303 - Stage 1 DN/Drawings/201879-303-001-001-001-001-301



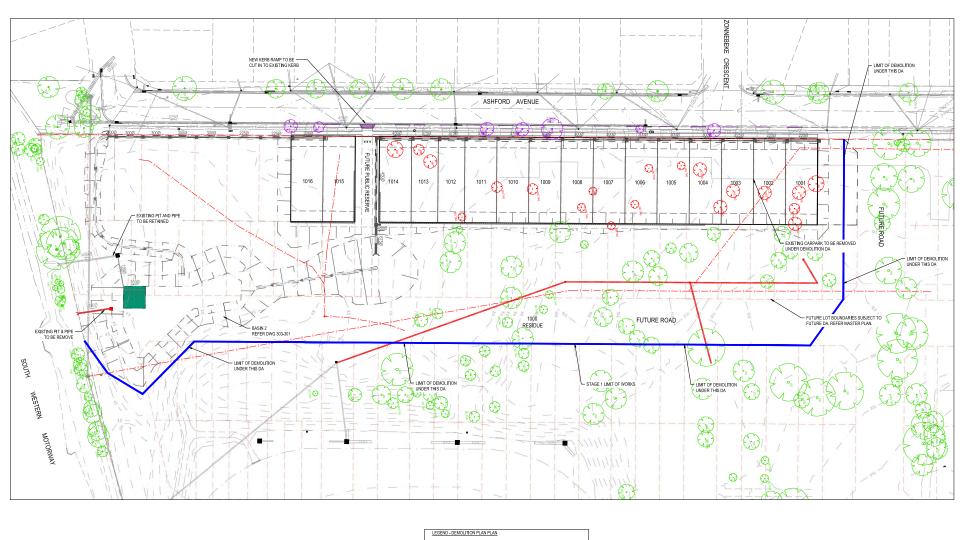

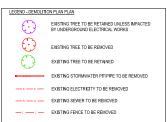WARNING
BEWARE OF UNDERGROUND SERVICES
The locations of underground services are approximate only and
their exact position should be proven on site.
No quarantee is given that all existing services are shown.
coatio all underground services before commencement of works

DIAL 1100 BEFORE YOU DIG

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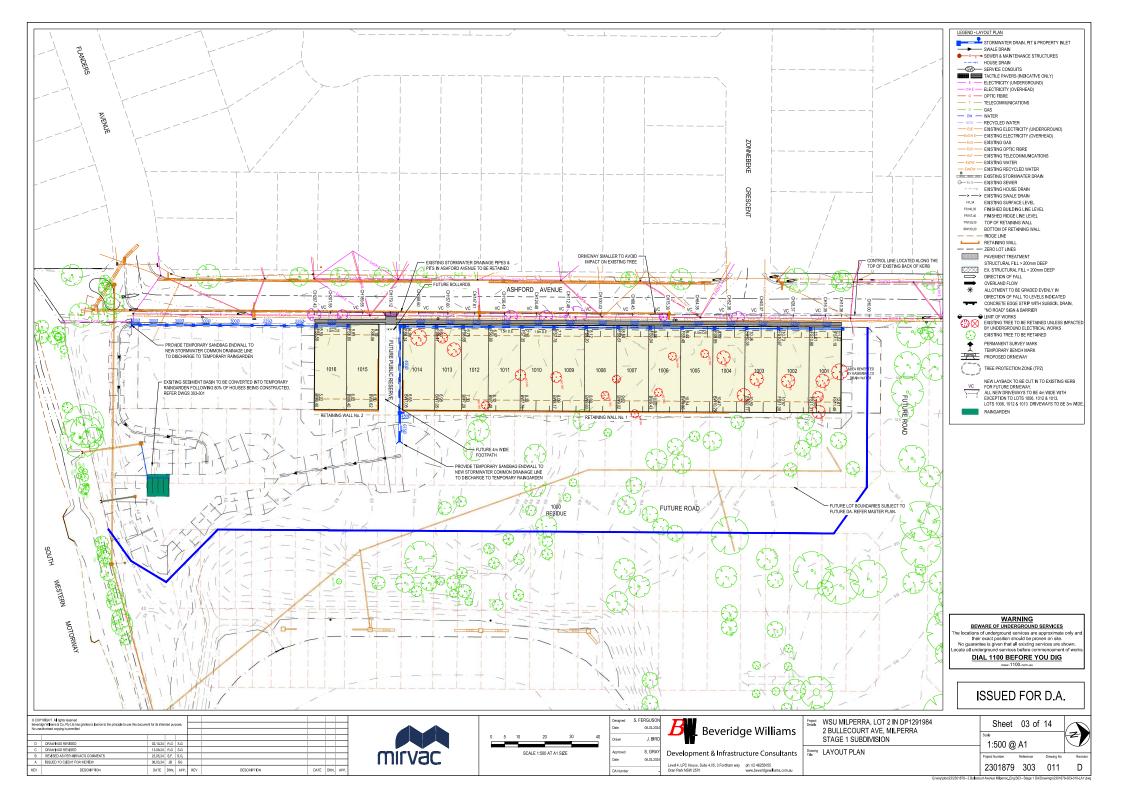
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	Approved	S. GRAY	Development & Infrastru	cture Consultants
	Date	08.03.2024	•	
	DA Number	-	Level 4, LPC House, Suite 4.05, 3 Fordham way Oran Park NSW 2570	ph: 02 46255055 www.beveridgewilliams.com.au


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RAY	Development & Infrastructure Consultant

ıs		2 BULLECOURT AVE, MILPE STAGE 1 SUBDIVISION
nts	Drawing Title	DEMOLITION PLAN


Project WSU MILPERRA, LOT 2 IN DP1291984

Sheet	02 of	14	/
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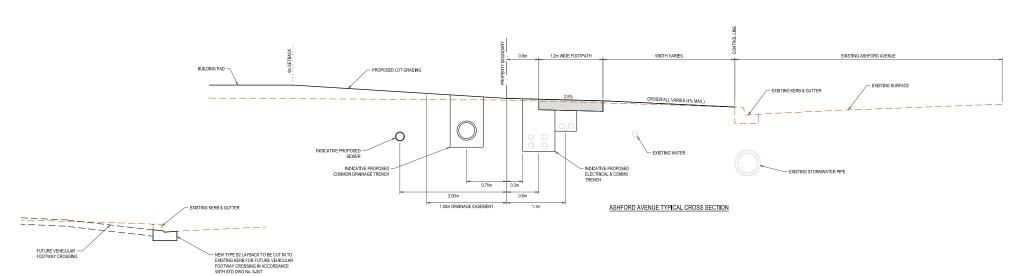


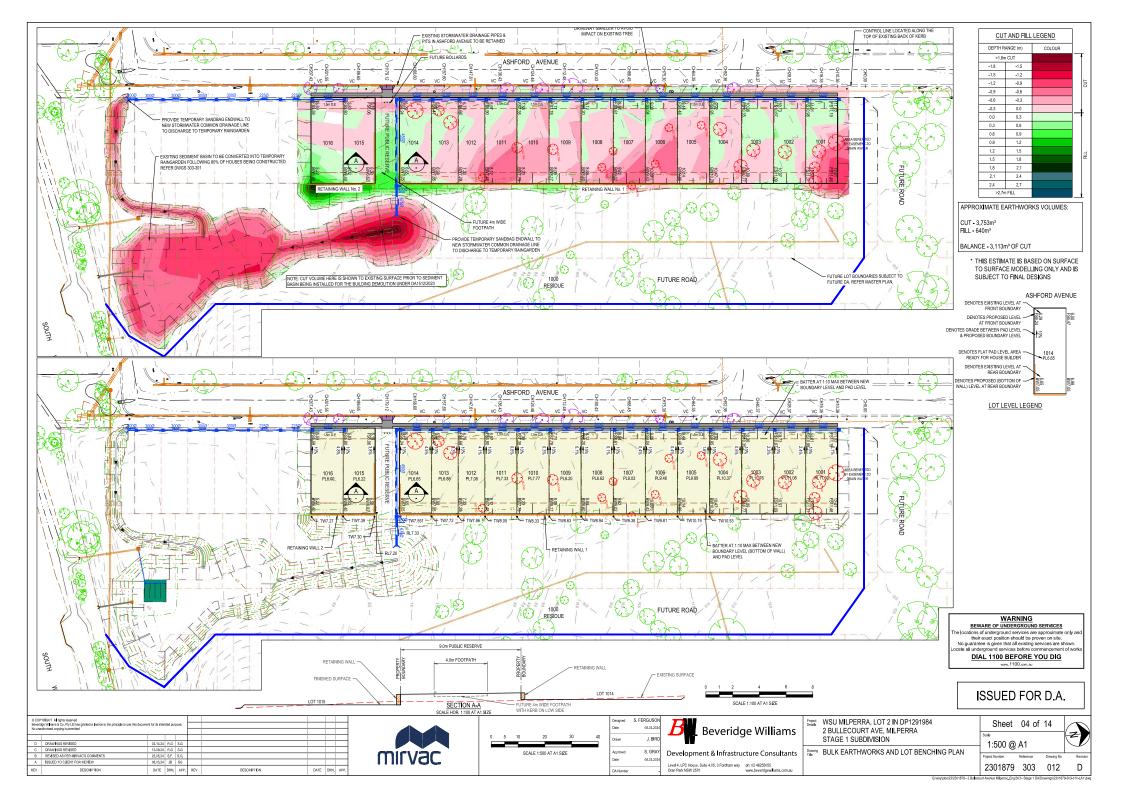

LEGEND - DESIGN LINE

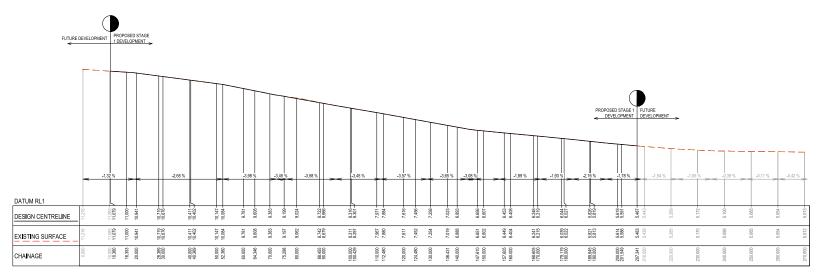

ASHFORD AVENUE EXISTING BACK OF KERB LONGITUDINAL SECTION Scales: HORZ 1:500 VERT 1:100



### LAYBACK FOR VEHICULAR CROSSING TYPICAL SECTION

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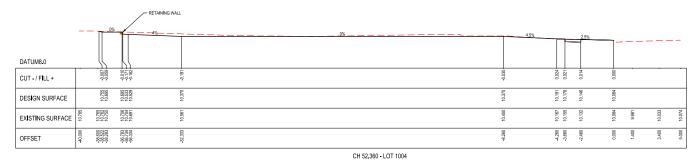
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6 Date 08.03.2024 DA Number -	Development & Infrastru Level 4, LPC House, Suite 4.05, 3 Fordham way Oran Park NSW 2570	cture Consultants ph: 02 48255055 www.beveridgewilliams.com.au

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′	Development & Infrastructure Consultants

Project Details	WSU MILPERRA, LOT 2 IN DP1291984 2 BULLECOURT AVE, MILPERRA STAGE 1 SUBDIVISION
Drawing Title	ASHFORD AVENUE BACK OF KERB LONGITUDINAL SECTION & TYPICAL CROSS SECTION

Sheet	05 of	14	
1:500 H	1:100 \	/ @ A1	
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CUT - / FILL +	ľ	0.000	0.028	0.158			0.034	-0.047	0.039	0.000			
DESIGN SURFACE		10.945	10.961	10.760			10.760	10.508	10.463	10.402			
EXISTING SURFACE	10.967	10.948 10.945	10.933	10.919			10.726	10.555	10.502	10.402	10.347	10.404	10.449
OFFSET	40.000	38.500 38.377 38.237	36.737	-32.336			-8.263	4.263	2.463	0.000	1.400	3.400	5.000

DATUM9.0 0.194 CUT - / FILL + 11.198 DESIGN SURFACE 11.005 10.852 EXISTING SURFACE 3.667 OFFSET

CH 40.369 - LOT 1003

CH 28.369 - LOT 1002

DATUM9.0 CUT - / FILL + 11.385 11.091 11.007 DESIGN SURFACE 11.010 EXISTING SURFACE 3,372 36.445 0.000 0.296 1.400 3,400 OFFSET

CH 16.353 - LOT 1001

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A	ISSUED TO CLIENT FOR REVIEW	08,03,24	./8	SG					
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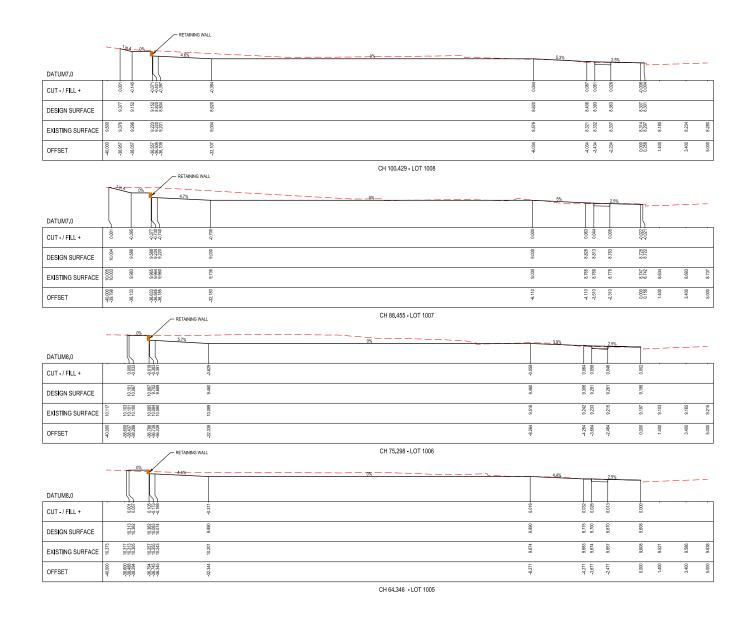
	Designed Date	S. FERGUSON 08.03.2024	/ /48	ge Williams			
8	Drawn	J. BIRD		•			
	Approved	S. GRAY	Development & Infrastru	cture Consultant			
	Date 06.03.2024		Level 4 LPC House, Suite 4.05, 3 Fordham way	ph: 02 46255055			
	DA Number	-	Oran Park NSW 2570	www.beveridgewilliams.com.a			

ON 124 RD	Reveridge William
ΑY	Development & Infrastructure Consultant

Project WSU MILPERRA, LOT 2 IN DP1291984 2 BULLECOURT AVE, MILPERRA STAGE 1 SUBDIVISION Development & Infrastructure Consultants Drawing LOT CROSS SECTIONS SHEET 1 OF 5

Sheet 06 of 14 1:100 @ A1





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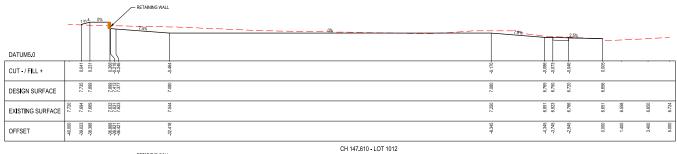
8	Designed Date Drawn	S. FERGUSON 08.03.2024 J. BIRD	/ /48	ge Wi <b>ll</b> iams				
	Approved Date	S, GRAY 08.03,2024	Development & Infrastru	cture Consultants				
	DA Number	-	Level 4, LPC House, Suite 4.05, 3 Fordham way Oran Park NSW 2570	ph: 02 46255055 www.beveridgewilliams.com.au				

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Development & Infrastructure Consultants


Project Details	WSU MILPERRA, LOT 2 IN DP1291 2 BULLECOURT AVE, MILPERRA STAGE 1 SUBDIVISION
Drawing Title	LOT CROSS SECTIONS SHEET 2 OF 5

Sheet 07 of 14	
1:100 @ A1	





				RETAINING WALL											
	-		<b>\</b>	6.8%	 	— <sub>0%</sub> — —	 		5%	_	2.5%				
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CUT - / FILL +		0.000	0.112	-1080-				0.078	-0.035	-0.037	-0.041	0.004			
DESIGN SURFACE		8.258	8.145 7.636 7.602	7.330				7.330	7.132	7,117	7.087	7.023			
EXISTING SURFACE	8.250	8.258	8.257 8.256 8.254	8.231				7.252	7.167	7,154	7.128	7.019	6.938	7,012	7.076
OFFSET	-40.000	-38.814	-36.860 -36.813 -36.413	-32.409				-8.336	4.336	3.736	2.536	0.009	1.400	3,400	5.000

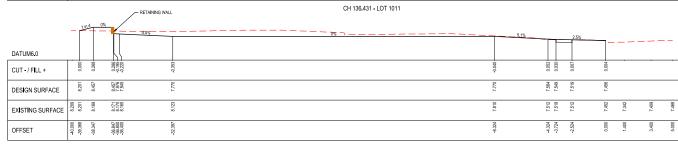



CH 112.480 - LOT 1009

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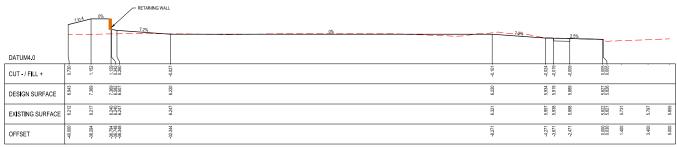
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	Approved Date	S. GRAY 08.03.2024	Development & Infrastru	cture Consultants				
	DA Number	-	Level 4, LPC House, Suite 4.05, 3 Fordham way Oran Park NSW 2570	ph: 02 46255055 www.beveridgewilliams.com.au				

ON 1024 RD	Beveridge William
ΑY	Development & Infrastructure Consultant

5	Project Details	WSU MILPERRA, LOT 2 IN DP1291984 2 BULLECOURT AVE, MILPERRA STAGE 1 SUBDIVISION
s	Drawing Title	LOT CROSS SECTIONS SHEET 3 OF 5


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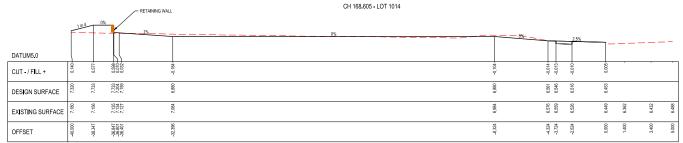




CH 189,645 - LOT 1015

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EXISTING SURFACE	6.580	6.566	9990 9990 9990 9990	6.189	6.122	6.039	5.943	6.003	6.055
OFFSET	40.000	-38.341	2. 2. 2. 2. 2. 2. 2. 2. 2. 2. 2. 2. 2. 2	4.318	-2.518	00000	1.400	3.400	9:000



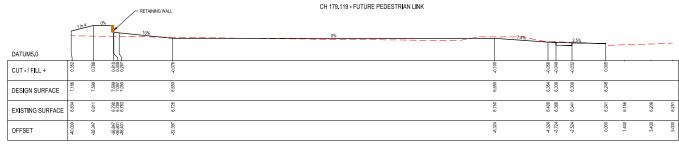

CH 157.605 - LOT 1013

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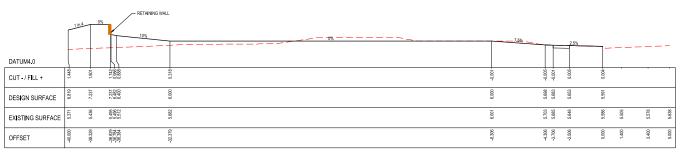
3	Date Drawn	S. FERGUSON 08.03.2024 J. BIRD	$m{B}$ Beveridge William					
	Approved	S. GRAY	Development & Infrastru	cture Consultants				
	Date	08,03,2024	Level 4, LPC House, Suite 4.05, 3 Fordham way	ph: 02 46255055				
	DA Number	-	Oran Park NSW 2570	www.beveridgewilliams.com.au				

4	$m{B}$ Beveridge Williams
7	Development & Infrastructure Consultants

Project Details	WSU MILPERRA, LOT 2 IN DP12 2 BULLECOURT AVE, MILPERRA STAGE 1 SUBDIVISION
Drawing Title	LOT CROSS SECTIONS SHEET 4 OF 5

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vi	1:100	@ A1		
	Project Number	Reference	Drawing No	R

LEGEND \_\_ \_\_ \_ EXISTING SURFACE \_\_\_ DESIGN SURFACE



CH 201.549 - LOT 1016

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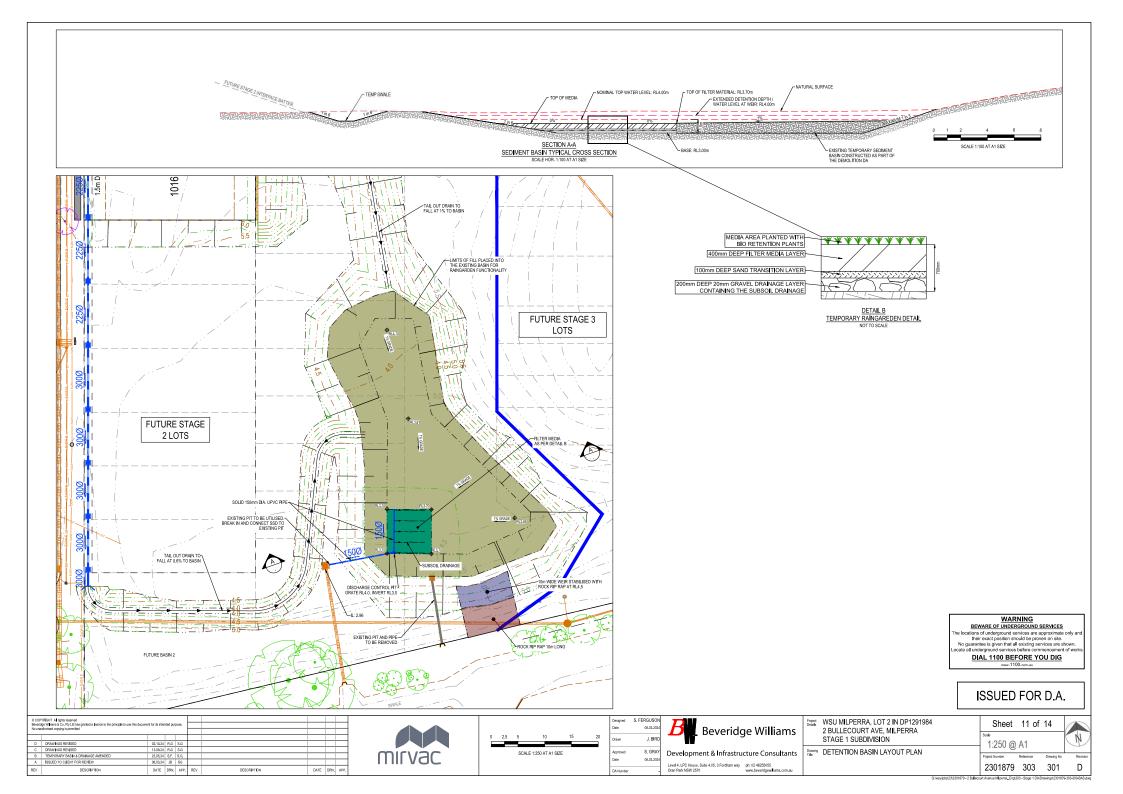






Designed Date	S. FERGUSON 08.03.2024		
Drawn	J. BIRD		
Approved	S. GRAY	Development & Infrastructure Consultants	
Date	08.03,2024	Level 4 LPC House, Suite 4.05, 3 Fordham way ph; 02 48255055	


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	2 BULLECOURT AVE, MILPERRA
Project Details	WSU MILPERRA, LOT 2 IN DP1291984


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structure Consultants	Drawing LOT CROSS SECTIONS		
structure consultants	SHEET 5 OF 5	Project Number	Reference
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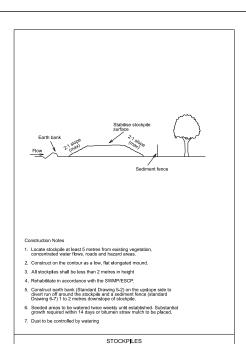





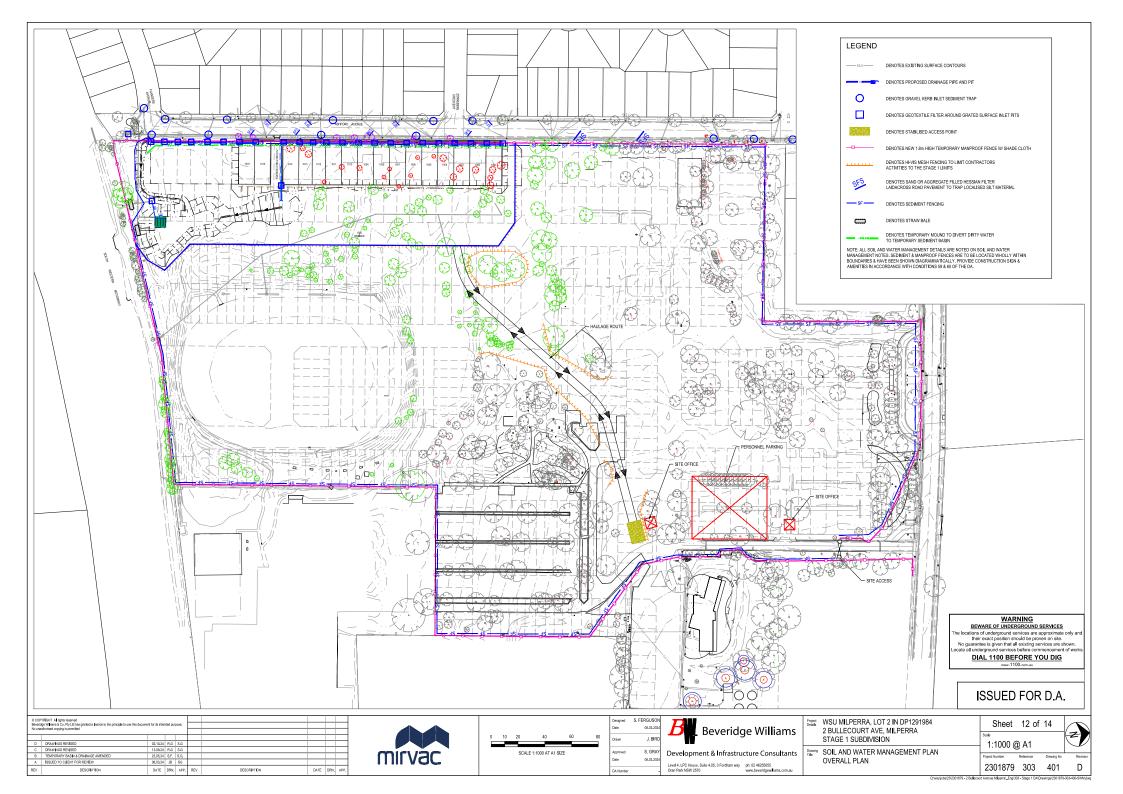


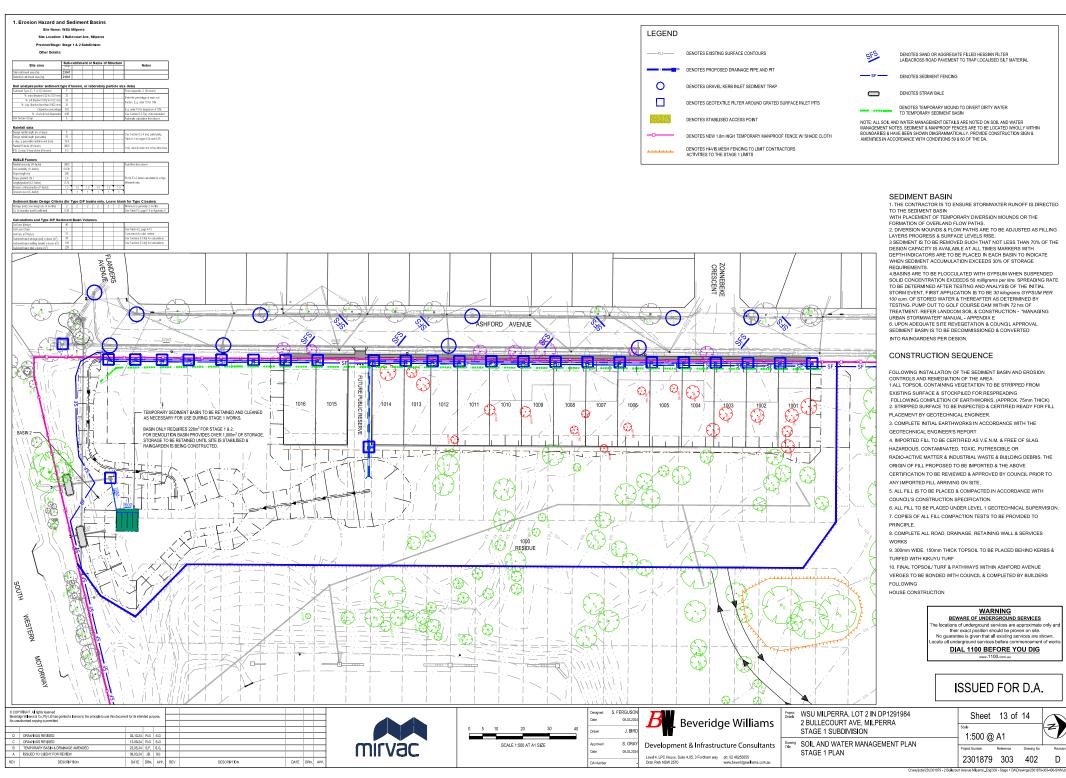


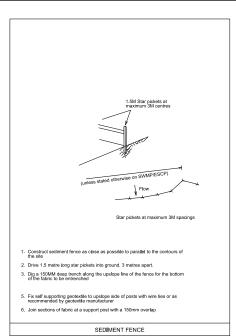

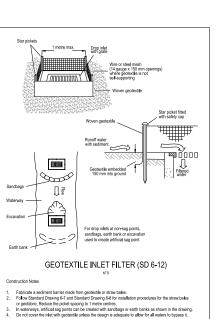

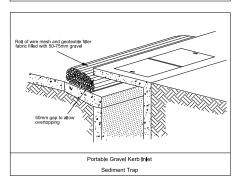

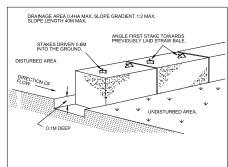

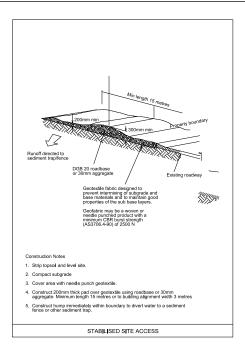

### SEDIMENT & EROSION CONTROL

- SE1. THE CONTRACTOR SHALL IMPLEMENT ALL SOIL EROSION AND SEDIMENT CONTROL MEASURES PRIOR TO DISTURBANCE OF THE WORK AREA & TO BE CARRIED OUT IN ACCORDANCE WITH LANDCOM'S "MANAGING URBAN STORMWATER - SOILS AND
- SE2. THE CONTRACTOR SHALL REGULARLY MAINTAIN ALL SEDIMENT AND EROSION CONTROL DEVICES AND REMOVE ACCUMULATED SILT FROM SUCH DEVICES BEFORE MORE THAN 60% OF THEIR CAPACITY IS LOST. ALL THE SILT REMOVED SHALL BE DISPOSED OF AS DIRECTED BY THE SUPERINTENDENT. NO SILT IS TO BE PLACED OUTSIDE THE LIMIT OF WORKS. THE PERIOD FOR MAINTAINING THESE DEVICES SHALL BE AT LEAST UNTIL ALL DISTURBED AREAS ARE REVEGETATED AND LONGER AS MAY BE DIRECTED BY THE SUPERINTENDENT OR COUNCIL.
- SE3. VEHICULAR TRAFFIC SHALL BE CONTROLLED DURING CONSTRUCTION CONFINING ACCESS WHERE POSSIBLE TO PROPOSED OR EXISTING ROAD ALIGNMENTS.
- SE4. WHEN ANY DEVICES ARE TO BE HANDED OVER TO COUNCIL, THEY SHALL BE IN A CLEAN & STABLE CONDITION.
- SE5. THE CONTRACTOR SHALL MAINTAIN ALL REVEGETATED AREAS INCLUDING WATERING UNTIL FINAL COMPLETION OF WORKS.
- SE6. THE CONTRACTOR SHALL MAINTAIN DUST CONTROL UNTIL FINAL COMPLETION OF WORKS.
- SET. THE CONTRACTOR'S RESPONSIBILITY IS TO ENSURE ALL NECESSARY MEASURES SO AS TO PROTECT ALL DISTURBED AREAS AS PER NOTE SE1. ALL ADDITIONAL COSTS ARE TO BE REFLECTED IN TENDER PRICE EVEN IF SLICH MEASURES ARE NOT INDICATED ON THE SEDIMENT AND EROSION CONTROL PLAN
- SE8. THE CONTRACTOR MUST COMMENCE REHABILITATION WITHIN 5 DAYS OF ANY SITE REGRADING & BATTER FORMATION
- SE9. A 0.3m WIDE STRIP OF TURF TO BE PLACED BEHIND THE EXISTING KERB IN ASHFORD
- SE10. PROVIDE TURF AROUND ALL SURFACE INLET PITS IN ADDITION TO THE GEOTEXTILE INLET
- SE11. STOCKPILES TO BE STABILISED WITHIN 14 DAYS OF COMPLETING THE STOCKPILE.

### NOTES

ALL EROSION AND SEDIMENT CONTROL MEASURES ARE TO BE INSTALLED AND MAINTAINED IN ACCORDANCE WITH THE LANDCOM'S MANUAL "MANAGING URBAN STORMWATER" 4TH EDITION AUGUST 2004.

WORKS SHALL BE UNDERTAKEN AS OUTLINED ON PLANS EROSION AND SEDIMENT CONTROL MEASURES AFFECTED BY WORKS ARE TO BE RE-ESTABLISHED PRIOR TO THE COMPLETION OF EACH DAY'S WORK.

THE CONTRACTOR IS TO STABILISE ALL STOCKPILES AND DISTURBED AREAS AS SOON AS THEY ARE FORMED TO FINAL LEVELS. STABILISATION TO BE BY HYDROSEEDING / SPRAY GRASS, OR AS DIRECTED BY COUNCIL ENGINEER.

SEED MIXTURE FOR FOOTWAYS AND OTHER AREAS UNDER THE CONTROL OF COUNCIL ARE TO BE IN ACCORDANCE WITH COUNCIL'S SPECIFICATION. FOR OTHER AREAS, THE LIST OF PLANT SPECIES FOR TEMPORARY COVER IS:

JAPANESE MILLET AND OATS(RYECORN) AT 25kg/ha EACH - SPRING/SUMMER JAPANESE MILLET AT 10kg/ha AND OATS(RYECORN) AT 30kg/ha - AUTUMN/WINTER

ALL SEEDED AREAS ARE TO BE WATERED TWICE WEEKLY.

WHERE SURFACE SLOPES ARE MORE THAN 4H:1V BATTER THEY SHALL BE TURFED.

DUST CONTROL MEASURES SHALL BE IMPLEMENTED CONTINUOUSLY DURING CONSTRUCTION WORKS. SUCH MEASURES ARE TO BE TO THE SATISFACTION OF THE SUPERINTENDENT AND COUNCIL.

TOPSOIL SHALL BE RESPREAD ON CONSTRUCTION AREAS AND STABILISED AS SOON AS POSSIBLE WITHIN 60 DAYS OF DISTURBANCE. ALL DISTURBED AREAS ARE TO BE LEFT WITH A SCARIFIED SURFACE AT ALL TIMES TO ENCOURAGE WATER INFILTRATION AND ASSIST WITH KEYING OF TOPSOIL.

FOLLOWING COMPLETION OF WORKS AND STABILISATION OF ALL DISTURBED SURFACES, ALL MATERIALS AND CONTROL MEASURES ARE TO BE REMOVED FROM SITE AND TEMPORARY BASINS FILLED, COMPACTED AND STABILISED.

ALL SITE ACCESS TO BE ACHIEVED FROM DESIGNATED SITE ACCESS. SITE ACCESS TO BE PROTECTED BY THE INSTALLATION OF AN APPROVED SHAKER RAMP. SHAKER RAMP TO BE REGULARLY MAINTAINED TO ENSURE EFFECTIVENESS.

UPON COMPLETION OF FINAL EARTHWORKS OR AFTER WRITTEN DIRECTION OF COUNCIL, IMMEDIATE SILT CONSERVATION TREATMENTS SHALL BE APPLIED SO AS TO RENDER AREAS THAT HAVE BEEN DISTURBED, EROSION PROOF WITHIN 14 DAYS.

ALL DISTURBED OVER ALL STORMWATER, POWER, TELEPHONE, GAS AND SEWER LINES NOT WITHIN STREETS IS TO BE SPRAY GRASSED AS SOON AS POSSIBLE BUT NO LATER THAN WITHIN 14 DAYS AFTER BACKFILL.

NO MORE THAN 150m OF TRENCH IS TO BE OPEN AT ANY ONE TIME. ALL TEMPORARY EARTH BERMS, DIVERSION AND SEDIMENT BASIN EMBANKMENTS ARE TO BE TRACK ROLLED, SEEDED OR MULCHED OR SPRAYED WITH BITUMEN AS SOON AS THEY HAVE BEEN FORMED.

ALL FILLS ARE TO BE LEFT WITH A WINDROW AT LEAST 20cm HIGH AT THE TOP OF THE SLOPE AT THE END OF EACH DAY'S EARTHWORKS AMD ALL EARTHWORK AREAS SHALL BE ROLLED EACH EVENING 10 "SEAL" THE EARTHWORKS.

STABILISATION OF ALL CUT AND FILL SLOPES SHALL BE COMMENCED WITHIN 14 DAYS OF COMPLETION OF FORMATION.

THE CONTRACTOR SHALL MAINTAIN AND PRODUCE ON REQUEST A LOGBOOK ON SITE DETAILING THE FOLLOWING-

- RECORDS OF ALL RAINFALL
  DALY CONDITION OF ALL RIGOSION AND SEDIMENT CONTROL MEASURES
  VOLUMES OF WAITER DISCHARGED FROM BASINS
  METHOD OF DISPOSAL OF WAITER FROM BASINS
  MY ADDITIONAL REMEDIAL WORKS REQUIRED.

THE ORIGINAL LOGBOOK SHALL BE ISSUED TO THE PROJECT MANAGER ON COMPLETION OF THE WORKS. SEDIMENT CONTROL MEASURES TO BE MONITORED ONCE A WEEK AND AFTER EVERY STORM EVENT.

STOCKPILES TO BE MAX 2 METRE HIGH WITH SEDIMENT FENCING TO LOW SIDE LOCATED CLEAR OF WATERCOURSES

ALL STORMWATER PITS TO BE BLOCKED DURING CONSTRUCTION UNTIL SITE STABILISED.

DURING CONSTRUCTION WORKS ANY WORK AND STORAGE AREAS WHERE SPILLAGE MAY OCCUR MUST BE BUNDED. THE SIZE OF THE AREA'T OBE BUNDED AND HEIGHT OF THE BUND WILLS USEN LARGEST STORAGE CONTAINER, WHICH EVER IS GREATER ALL PIEW WORK EXTENDING PROMITHE BUNDED AREA MUST BE DIRECTED OVER THE BUND WALL AND HOSE COUPLINGS MUST BE PLACED SUCH THAT LEAKS AND SPILLAGES ARE CONTAINER. THE AREAS MUST BE GRADED TO A PITISIUMP

ANY IMPORTED FILL USED MUST BE VALIDATED & SUITABLE & FREE OF SALINE & CONTAMINATION

### WARNING

BEWARE OF UNDERGROUND SERVICES locations of underground services are approximate only ar their exact position should be proven on site. No guarantee is given that all existing services are shown cate all underground services before commencement of wor

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ISSUED FOR D.A.





Designed	S. FERGUSON
Date	08.03.2024
Drawn	J. BIRD
Approved	S. GRAY
Date	08.03.2024
DA Number	



Level 4, LPC House, Suite 4.05, 3 Fordham way ph: 02 46255055 Cran Park NSW 2570 www.bevendgewilliams.com.a

Project WSU MILPERRA, LOT 2 IN DP1291984 2 BULLECOURT AVE, MILPERRA STAGE 1 SUBDIVISION

Drawing SOIL AND WATER MANAGEMENT PLAN DETAILS & NOTES

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